

#### INDEX OF SHEETS SHEET NO. DESCRIPTION COVER SHEET S-2GENERAL NOTES S-3OVERALL PLAN OF BRIDGE OVERALL ELEVATION OF BRIDGE S-5TYPICAL SECTIONS S-6PLAN & PROFILE ALIGNMENT "A" S - 7LEVEE ROAD CROSS SECTIONS S-8 LEVEE ROAD CROSS SECTIONS S-9 LEVEE ROAD CROSS SECTIONS S-10 STORM WATER POLLUTION PREVENTION PLAN TEMP. SEDIMENT CONTROL FENCE S-12 CONSTRUCTION EXITS S-13

# PLANS FOR THE DEMOLITION OF THE UNITED STATES SECTION:

# FABENS-CASETA INTERNATIONAL BRIDGE

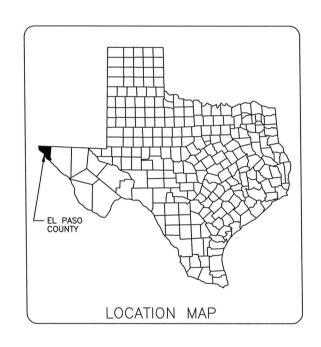

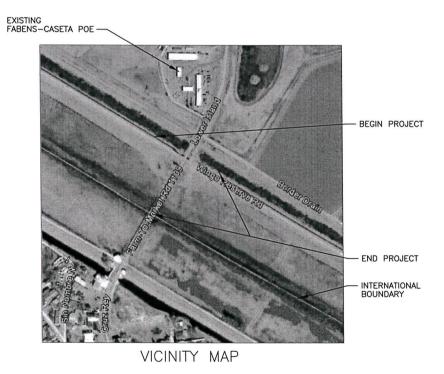



FINAL PLAN DATA:

FINAL CONTRACT PRICE:

DATE WORK COMPLETED: DATE OF ACCEPTANCE:

CONTRACTOR'S NAME: \_\_\_\_\_\_

CONTRACTOR'S ADDRESS: \_\_\_\_\_

LETTING DATE: \_\_\_\_\_

DATE WORK BEGINS: \_\_\_\_\_

STRUCTURAL ENGINEERING
ASSOCIATES, INC.
CONSULTING ENGINEERS
TBPE FIRM REGISTRATION # F-199



TBPE FIRM REG. NO. F-199

#### **GENERAL NOTES:**

- 1 CONTRACTOR SHALL FAMILIARIZE HIMSELF WITH THE PROJECT, PROJECT SITE AND ACCESS TO THE SITE.
- a. ALL INFORMATION SHOWN ON THESE PLANS RELATING TO EXISTING BRIDGE CONFIGURATION, DIMENSIONS AND MEMBER SIZES IS FOR GENERAL INFORMATION ONLY.
- CONTRACTOR SHALL VERIFY ALL EXISTING BRIDGE INFORMATION THAT MAY AFFECT HIS COSTS PRIOR TO SUBMITTING HIS BID.
- c. THE COUNTY OF EL PASO ASSUMES NO RESPONSIBILITY FOR THE ACTUAL CONDITION OR THE STRUCTURAL ADEQUACY OF THE EXISTING BRIDGE. THE CONTRACTOR SHALL MAKE OWN DETERMINATION OF THE ACTUAL CONDITION AND STRUCTURAL ADEQUACY OF THE EXISTING BRIDGE.CONTRACTOR SHALL SUBMIT A DEMOLITION PLAN SIGNED AND SEALED BY A TEXAS LICENSED PROFESSIONAL ENGINEER.
- d. THE CONTRACTOR IS CAUTIONED THAT THE PROJECT SITE IS WITHIN THE RIO GRANDE RIVER FLOOD PLAIN.
- 2. THE PROJECT SITE IS WITHIN THE JURISDICTION OF THE INTERNATIONAL BOUNDARY AND WATER COMMISSION (IBWC), THE U.S. COAST GUARD, THE U.S. BORDER PATROL AND OTHER FEDERAL AGENCIES; THE CONTRACTOR SHALL FAMILIARIZE HIMSELF WITH THEIR REQUIREMENTS AND COMPLY WITH THEM. SOME OF THEIR REQUIREMENTS INCLUDE:
- a. ALL CONTRACTOR'S EMPLOYEES ARE SUBJECT TO A BACKGROUND SCREENING BY U.S. BORDER PATROL. EMPLOYEES NOT PASSING THE BACKGROUND SCREENING WILL NOT BE ALLOWED TO WORK ON THIS PROJECT SITE.
- b. ACCESS TO THE PROJECT SITE IS ONLY THROUGH EXISTING GATES IN THE BORDER FENCE. DIRECT ACCESS IS AVAILABLE AT THE WINGO RESERVE GATE, WHICH IS APPROXIMATELY 2.0 MILES UP STREAM. DIRECT ACCESS AT THE FABENS GATE IS NOT AVAILABLE ON A PUBLIC THOROUGH FARE. CONTRACTOR MAY OBTAIN PERMISSION FROM ADJACENT LAND OWNER TO ACCESS FABENS GATE FROM COUNTY ROAD. ACCESS THROUGH FABENS PORT OF ENTRY (POE) GATE IS NOT PERMITTED.
- 3. THE PROJECT SITE IS WITHIN THE FLOODPLAIN OF THE RIO GRANDE RIVER. AS SUCH CERTAIN HOUSE KEEPING MEASURES ARE REQUIRED DURING DEMOLITION/CONSTRUCTION.
- a. CONTRACTOR SHALL TAKE ADEQUATE MEASURES SO THAT NO DEBRIS WILL BE ALLOWED TO FALL INTO THE LOW FLOW CHANNEL OF THE RIVER.
- b. ALL DEBRIS OR MATERIAL REMOVED FROM THE OLD BRIDGE OR LEVEE MUST BE COMPLETELY REMOVED FROM THE BRIDGE SITE AND FLOOD PLAIN, CONTRACTOR WILL NOT BE ALLOWED TO STORE ANY MATERIALS OR DEBRIS IN THE FLOODPLAIN.
- c. PIER NO. 8 AND NO. 9 LOCATED WITHIN THE LOW FLOW CHANNEL OF THE RIVER MUST BE REMOVED BELOW THE LOW FLOW CHANNEL BOTTOM OR THE EXISTING FLOOD PLAIN TO THREE (3) FEET BELOW THE LOWEST EXISTING GROUND SURFACE ELEVATION ALONG THE PIER CENTERLINE BETWEEN 10 FEET UPSTREAM AND 10 FEET DOWNSTREAM OF THE EDGE OF THE BRIDGE. ELEVATIONS TO BE DETERMINED IN THE FIELD BY THE CONTRACTOR AND FIELD VERIFIED BY EL PASO COUNTY.
- d. ABUTMENT #1, PIERS #2-#7 AND TIMBER RETAINING WALL SHALL BE REMOVED WITHIN THE RIVER FLOODPLAIN TO THREE (3) FEET BELOW THE LOWEST EXISTING GROUND SURFACE ELEVATION ALONG THE PIER CENTERLINE BETWEEN 10 FEET UPSTREAM AND 10 FEET DOWNSTREAM OF THE EDGE OF THE BRIDGE. ELEVATIONS TO BE DETERMINED IN THE FIELD BY THE CONTRACTOR AND FIELD VERIFIED BY EL PASO COUNTY.
- e. DEWATERING MAY BE REQUIRED FOR REMOVAL OF STRUCTURES BELOW GROUND SURFACE.
- f. DIVERSION OF RIVER WATER FLOW FROM THE PIER AREAS OR FOR RIVER ACCESS IS PROHIBITED.
- g. THE CONTRACTOR MUST SUBMIT A DEMOLITION SCHEDULE FOR APPROVAL PRIOR TO COMMENCING WORK.
- 4. BURNING AT THE PROJECT SITE FOR DISPOSAL OF REFUSE AND DEBRIS WILL NOT BE PERMITTED.
- 5. THE USE OF EXPLOSIVES WILL NOT BE PERMITTED.
- 6. AREA LIGHTING AND POWER POLE FOR AREA LIGHTING ARE TO BE REMOVED AS A PART OF THIS PROJECT. CONTRACTOR IS REQUIRED TO COORDINATE WITH U.S. BORDER PATROL AND EL PASO ELECTRIC COMPANY TO GET THE LINES DE-ENERGIZED.
- CONTRACTOR IS REQUIRED TO RE-VEGITATE ALL AREAS WITHIN CONSTRUCTION LIMITS DISTURBED BY CONSTRUCTION OPERATIONS.

#### SPECIFICATION NOTES:

#### SCOPE OF WORK

ALL COORDINATION WITH EXISTING UTILITIES IS THE RESPONSIBILITY OF THE CONTRACTOR. THE CONTRACTOR SHALL BE REQUIRED TO CONTACT ALL UTILITIES TO FIELD LOCATE ALL EXISTING UTILITIES IN THE WORK AREA.

ALL OF THE ITEMS FOR THIS PROJECT UNDER WHICH PAYMENT IS TO BE MADE ARE PLANS QUANTITY MEASUREMENT AND AS SUCH THE QUANTITY TO BE PAID IS THE QUANTITY SHOWN IN THE PROPOSAL. ANY OTHER WORK INDICATED WITHIN THE PLAN SHEETS SHALL BE CONSIDERED SUBSIDIARY TO THE VARIOUS BID ITEMS.

ITEM 31 92 00 SEED MIXES USED SHALL BE US IBWC COMPLIANCE APPROVED FOR USE IN EL PASO COUNTY AND BE COMPATIBLE WITH THE TOPSOIL.

#### ITEM 35 41 00 EXCAVATION (LEVEE)

THIS ITEM SHALL COVER THE EXCAVATION OF ALL MATERIAL, EXCLUDING THE TOPSOIL FOR STOCKPILE, AND INCLUDES BUT IS NOT LIMITED TO EXCESS TOPSOIL, EXCESS LEVEE MATERIAL, EXISTING ROADWAY BASE, AND BENCH EXCAVATION.

#### ITEM 35 41 00 FILL (IMPERVIOUS MATERIAL)

THIS ITEM SHALL COVER THE PLACEMENT OF FILL MATERIAL TO BRING THE LEVEE CROSS SECTIONS TO THE LINES AND GRADES AS INDICATED WITHIN THE PLANS. USE CLEAN FILL: FILL MATERIAL THAT MEETS OR EXCEEDS THE TCEQ TEXAS RISK REDUCTION PROGRAM (TRRP) RULES (30 TAC SEC. 350.51(m), MEDIAN BACKGROUND CONCENTRATION LEVELS.

PRIOR TO PLACEMENT OF IMPERVIOUS FILL MATERIAL, THE SUBGRADE TO RECEIVE THE FILL MATERIAL SHALL BE SCARIFIED, MOISTURE CONDITIONED AND RE-COMPACTED TO A MINIMUM OF NINETY FIVE PERCENT (95%) OF THE MAXIMUM DRY DENSITY AS DETERMINED BY ASTM D1557. SUBSEQUENT LIFTS OF IMPERVIOUS FILL MATERIAL SHALL BE MOISTURE CONDITIONED AND COMPACTED TO 95% OF THE MAXIMUM DRY DENSITY AS DETERMINED BY ASTM D1557

#### ITEM 35 41 00 TOPSOIL

THIS ITEM SHALL COVER THE PLACEMENT OF STOCKPILED TOPSOIL MATERIAL ON THE LEVEE FRONT SLOPE, IN ACCORDANCE WITH THE FINISHED LINES AND GRADES ON THE PLANS, AND PLACEMENT OF NEW TOPSOIL MATERIAL BROUGHT FROM OFF-SITE SOURCE.

ASTM D5268 REQUIREMENTS FOR TOPSOIL WILL BE AS APPLICABLE FOR THE EL PASO COUNTY GEOGRAPHIC AREA.

#### ITEM 32 15 ROADWAY BASE (FLEXIBLE BASE)

ROADWAY BASE SHALL BE AGGREGATE ROAD SURFACING MATERIAL MEETING THE SPECIFICATIONS AND AS SHOWN BELOW:

PROPERTY	TEST METHOD	AGGREGATE SURFACING
MASTER GRADATION SIEVE SIZE % PASSING		
1 1/2 IN. 3/8 IN. NO. 4 NO. 40	ASTM D422	0-10 50-85 35-65 15-30
LIQUID LIMIT, % MAX	ASTM D4318	40
PLASTICITY INDEX, MAX. PLASTICITY INDEX, MIN.	ASTM D4318	12 4
SPECIFIC GRAVITY, MIN.	ASTM C127/C128	2.40
LA ABRASION, MAX. LOSS	ASTM C131	20%

			BID ITEMS	
ITEM NO.	QTY	UNIT	DESCRIPTION	GOV. SPEC.
1	1	LS	PREPARING RIGHT OF WAY	31 11 00
2	240.0	CY	REMOVE/STOCKPILE EXISTING MATERIAL (TOPSOIL)	31 14 00
3	2500.0	CY	EXCAVATION (LEVEE)	35 41 00
4	415.0	CY	FILL (IMPERVIOUS MATERIALS)	35 41 00
5	240.0	CY	TOPSOIL	35 41 00
6	163.0	CY	ROADWAY BASE	32 15 00
7	1	EA	REMOVE OLD STRUCTURE (TIMBER BRIDGE)	
8	13,725.0	SY	SEEDING FOR EROSION CONTROL	32 92 00
9	611.0	LF	TEMPORARY SEDIMENT CONTROL FENCE	01 57 13
10	611.0	LF	TEMPORARY SEDIMENT CONTROL FENCE (REMOVE)	01 57 13
11	78.0	SY	CONSTRUCTION EXIT	01 57 13
12	78.0	SY	CONSTRUCTION EXIT (REMOVE)	01 57 13
13	1	LS	MOBILIZATION	
14	1	LS	DEWATERING	

ALL OF THE ITEMS FOR THIS PROJECT UNDER WHICH PAYMENT IS TO BE MADE ARE PLANS QUANTITY MEASUREMENT AND AS SUCH THE QUANTITY TO BE PAID IS THE QUANTITY SHOWN IN THE PROPOSAL. ANY OTHER WORK INDICTED WITHIN THE PLAN SHEETS SHALL BE CONSIDERED SUBSIDIARY TO THE VARIOUS BID ITEMS.

#### CONSTRUCTION PHASES:

PHASE 1 - DEMOLITION OF BRIDGE:

DEMOLITION AND REMOVAL OF ALL BRIDGE TIMBER PILES, CROSS BRACING, LAGGING, DIAFRAMS, BEAMS, DECKING, SIDEWALK AND PIPE RAILS FROM ABUTMENT NO.1 THROUGH BENT NO.9 AND SPAN NO.9

PHASE 2 - LEVEE IMPROVEMENTS:

REMOVAL OF TIMBER RETAINING WALL AND LAGGING, TIMBER/STEEL POSTS, CONCRETE BARRIERS, CONCRETE SLABS, CHAIN LINK FENCING AND GATE, SITE LIGHT POLES, EXISTING LEVEE EMBANKMENT/TOPSOIL/ROAD BASE AND OTHER ITEMS. CONSTRUCTION OF LEVEE AND LEVEE ROAD.





## THE COUNTY OF EL PASO




STRUCTURAL ENGINEERING ASSOCIATES, INC.


CONSULTING ENGINEERS


DEMOLITION OF FABENS CASETA INTERNATIONAL BRIDGE

GENERAL NOTES

DWN.	DESIGN	DATE	SHEET NO.
A.M.H.	G.J.S.	9-14-16	
DWG. CK.	DESIGN CK.	DRAWING FILE	1 S-2
S.A.M.	S.A.M.	16-003C	~ -

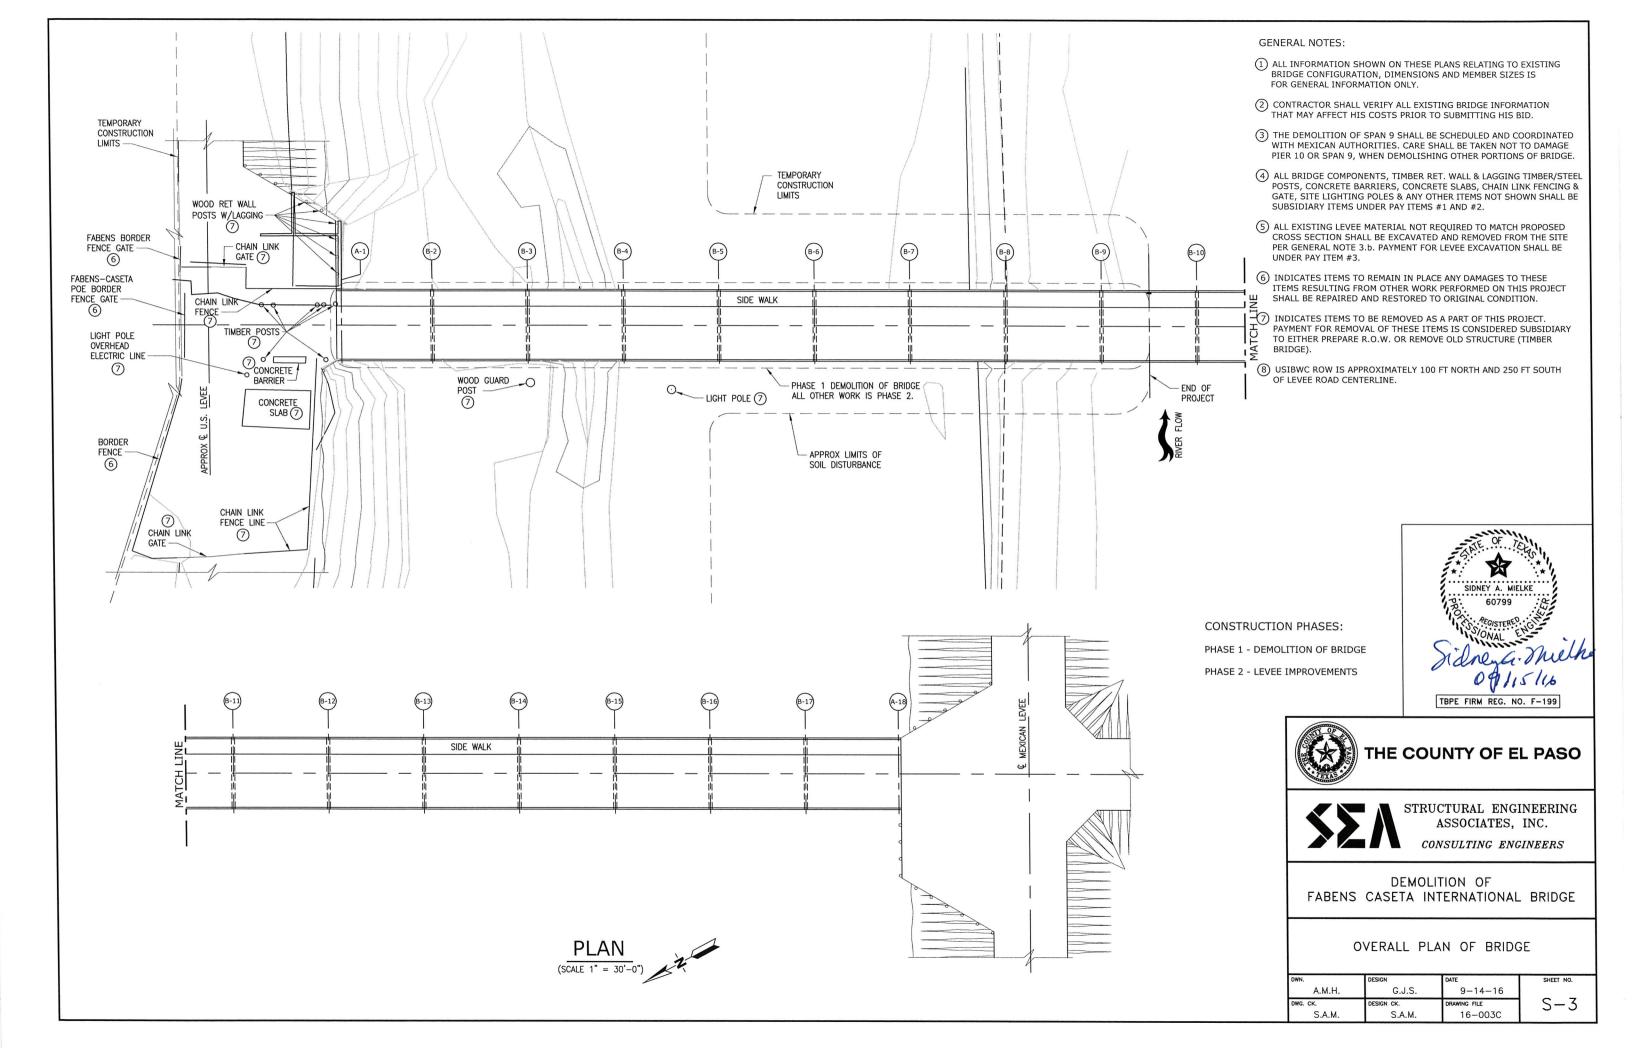

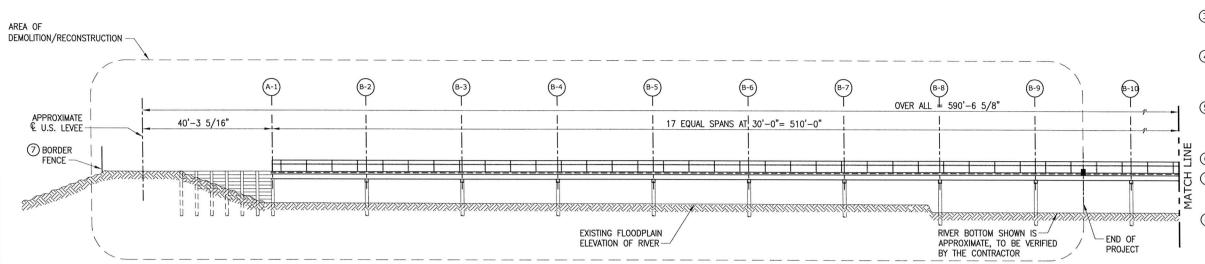

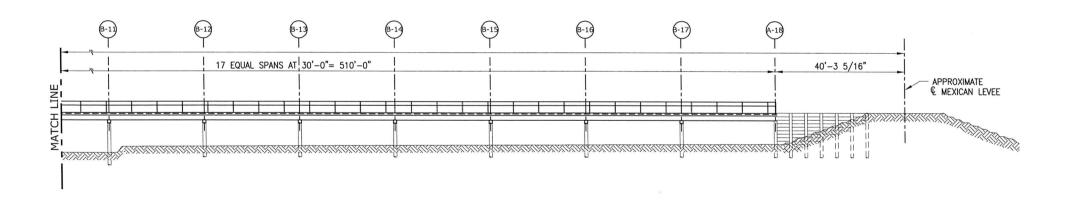


# (SCALE 1" = 30'-0")

## PHASE 1 - DEMOLITION OF BRIDGE

#### GENERAL NOTES:

- (1) ALL INFORMATION SHOWN ON THESE PLANS RELATING TO EXISTING BRIDGE CONFIGURATION, DIMENSIONS AND MEMBER SIZES IS FOR GENERAL INFORMATION ONLY.
- (2) CONTRACTOR SHALL VERIFY ALL EXISTING BRIDGE INFORMATION THAT MAY AFFECT HIS COSTS PRIOR TO SUBMITTING HIS BID.
- (3) THE DEMOLITION OF SPAN 9 SHALL BE SCHEDULED AND COORDINATED WITH MEXICAN AUTHORITIES. CARE SHALL BE TAKEN NOT TO DAMAGE PIER 10 OR SPAN 9, WHEN DEMOLISHING OTHER PORTIONS OF BRIDGE.
- 4 ALL BRIDGE COMPONENTS, TIMBER RET. WALL & LAGGING TIMBER/STEEL POSTS, CONCRETE BARRIERS, CONCRETE SLABS, CHAIN LINK FENCING & GATE, SITE LIGHTING POLES & ANY OTHER ITEMS NOT SHOWN SHALL BE SUBSIDIARY ITEMS UNDER PAY ITEMS #1 AND #2.
- (5) ALL EXISTING LEVEE MATERIAL NOT REQUIRED TO MATCH PROPOSED CROSS SECTION SHALL BE EXCAVATED AND REMOVED FROM THE SITE PER GENERAL NOTE 3.b. PAYMENT FOR LEVEE EXCAVATION SHALL BE UNDER PAY ITEM #3.
- 6 LIGHT POLE, POST, FENCING AND GATES NOT SHOWN FOR CLARITY.
- (7) BORDER FENCE TO REMAIN IN PLACE ANY DAMAGE TO THE BORDER FENCE RESULTING FROM WORK PERFORMED ON THIS PROJECT SHALL BE REPAIRED AND RESTORED TO ORIGINAL CONDITION.
- (8) USIBWC ROW IS APPROXIMATELY 100 FT NORTH AND 250 FT SOUTH OF LEVEE ROAD CENTERLINE.

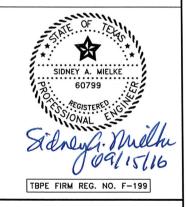



## THE COUNTY OF EL PASO




STRUCTURAL ENGINEERING ASSOCIATES, INC.

 ${\it CONSULTING~ENGINEERS}$ 

DEMOLITION OF FABENS CASETA INTERNATIONAL BRIDGE

OVERALL ELEVATION OF BRIDGE

DWN.	DESIGN	DATE	SHEET NO.
A.M.H.	G.J.S.	9-14-16	
DWG. CK.	DESIGN CK.	DRAWING FILE	1 5-4
S.A.M.	S.A.M.	16-003C	

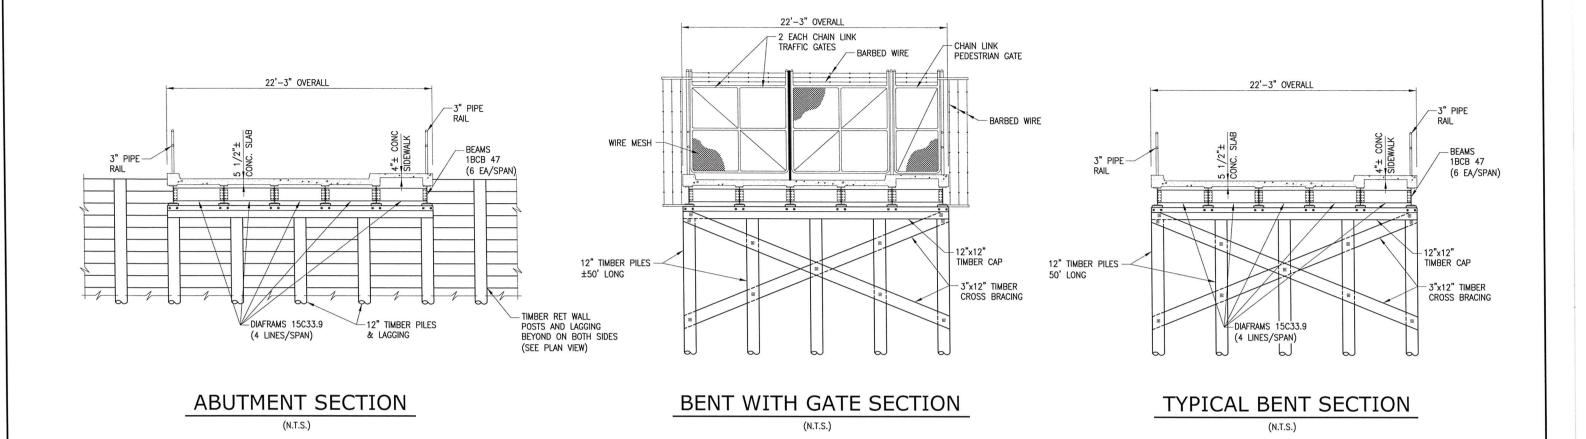

#### **GENERAL NOTES:**

- 1 PIER NO. 8 AND NO. 9 LOCATED WITHIN THE LOW FLOW CHANNEL OF THE RIVER MUST BE REMOVED BELOW THE LOW FLOW CHANNEL BOTTOM OR THE EXISTING FLOOD PLAIN TO THREE (3) FEET BELOW THE LOWEST EXISTING GROUND SURFACE ELEVATION ALONG THE PIER CENTERLINE BETWEEN 10 FEET UPSTREAM AND 10 FEET DOWNSTREAM OF THE EDGE OF THE BRIDGE. ELEVATIONS TO BE DETERMINED IN THE FIELD BY THE CONTRACTOR AND FIELD VERIFIED BY EL PASO COUNTY.
- 2. ABUTMENT #1, PIERS #2-#7 AND TIMBER RETAINING WALL SHALL BE REMOVED WITHIN THE RIVER FLOODPLAIN TO THREE (3) FEET BELOW THE LOWEST EXISTING GROUND SURFACE ELEVATION ALONG THE PIER CENTERLINE BETWEEN 10 FEET UPSTREAM AND 10 FEET DOWNSTREAM OF THE EDGE OF THE BRIDGE. ELEVATIONS TO BE DETERMINED IN THE FIELD BY THE CONTRACTOR AND FIELD VERIFIED BY EL PASO COUNTY.
- 3. DEWATERING MAY BE REQUIRED FOR REMOVAL OF STRUCTURES BELOW GROUND SURFACE.

#### CONSTRUCTION PHASES:

PHASE 1 - DEMOLITION OF BRIDGE

PHASE 2 - LEVEE IMPROVEMENTS



## THE COUNTY OF EL PASO



STRUCTURAL ENGINEERING ASSOCIATES, INC.

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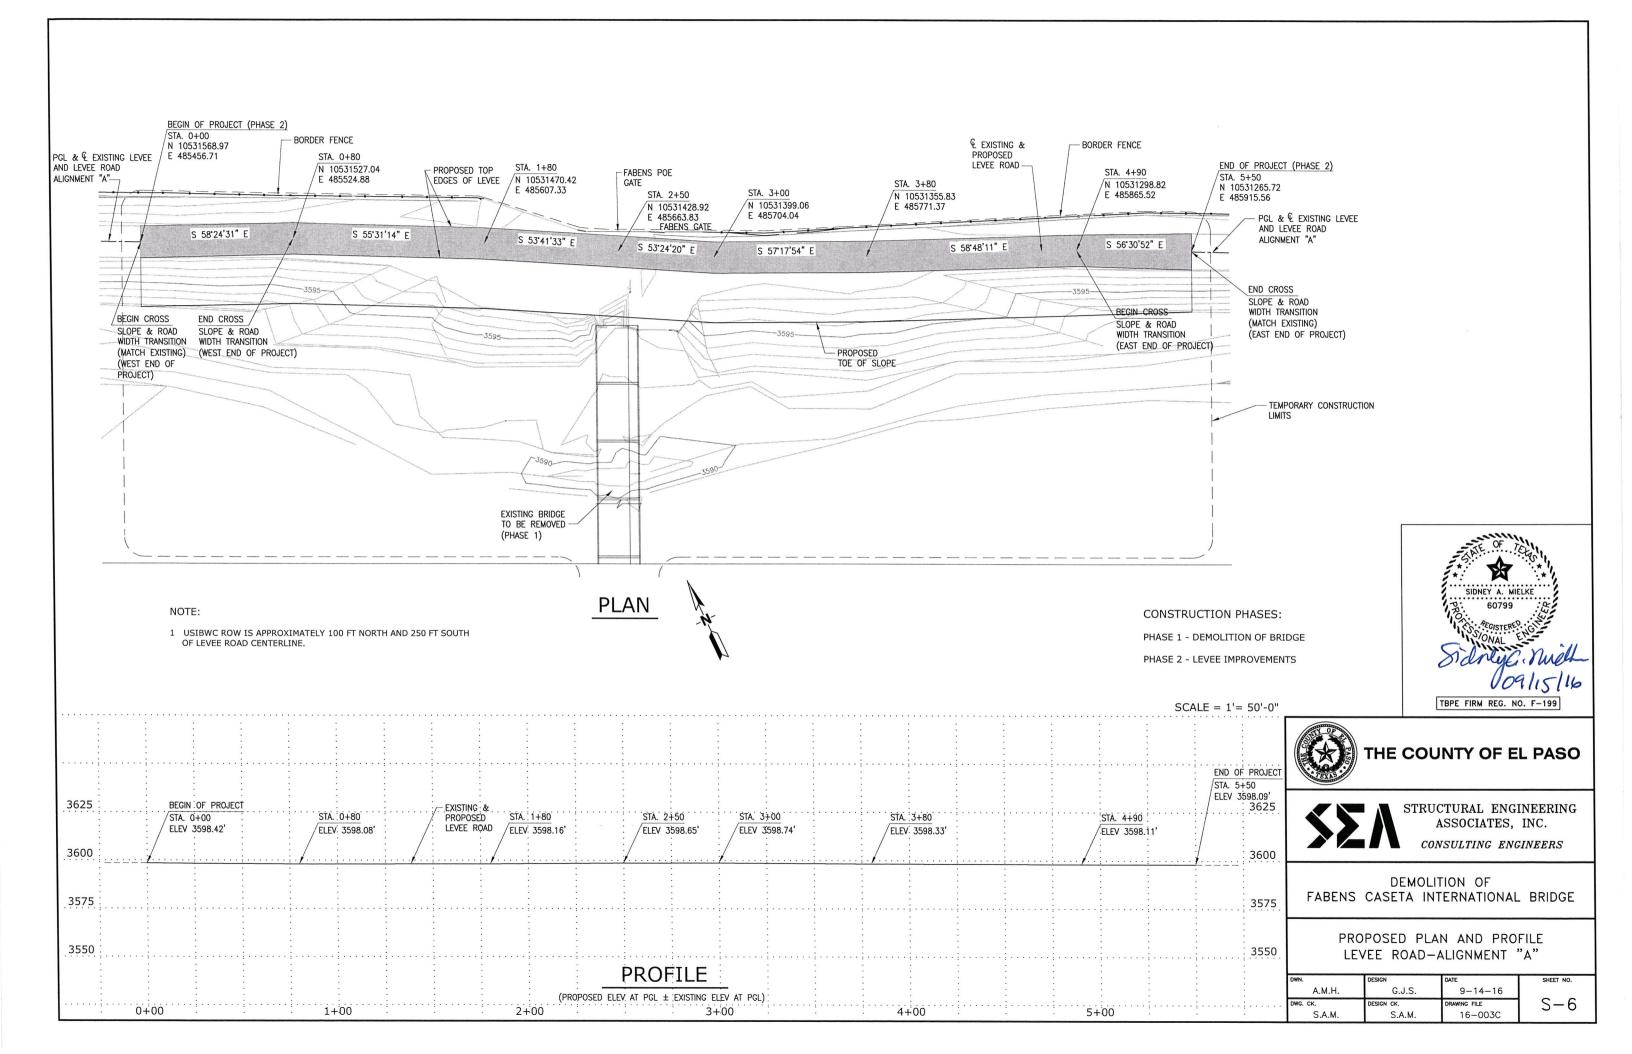
DEMOLITION OF FABENS CASETA INTERNATIONAL BRIDGE


TYPICAL SECTIONS

G.J.S. 9-14-16 S.A.M. S.A.M. 16-003C



TBPE FIRM REG. NO. F-199



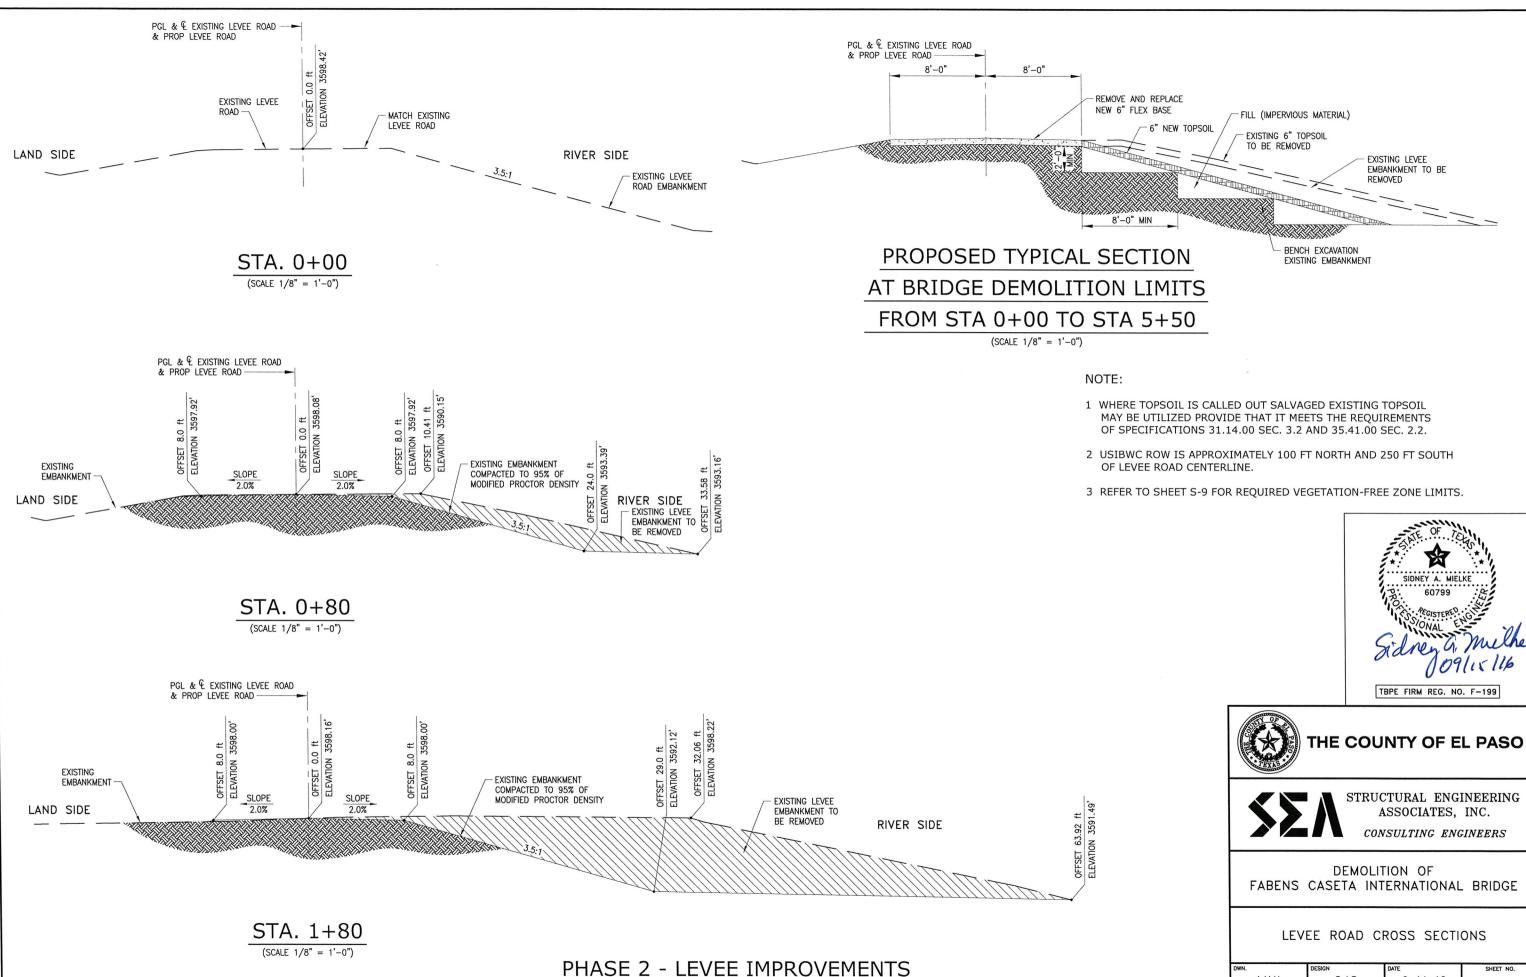


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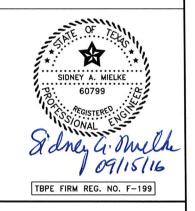
 G.J.S.
 9-14-16

 DWG. CK.
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 DRAWING FILE

 S.A.M.
 16-003C

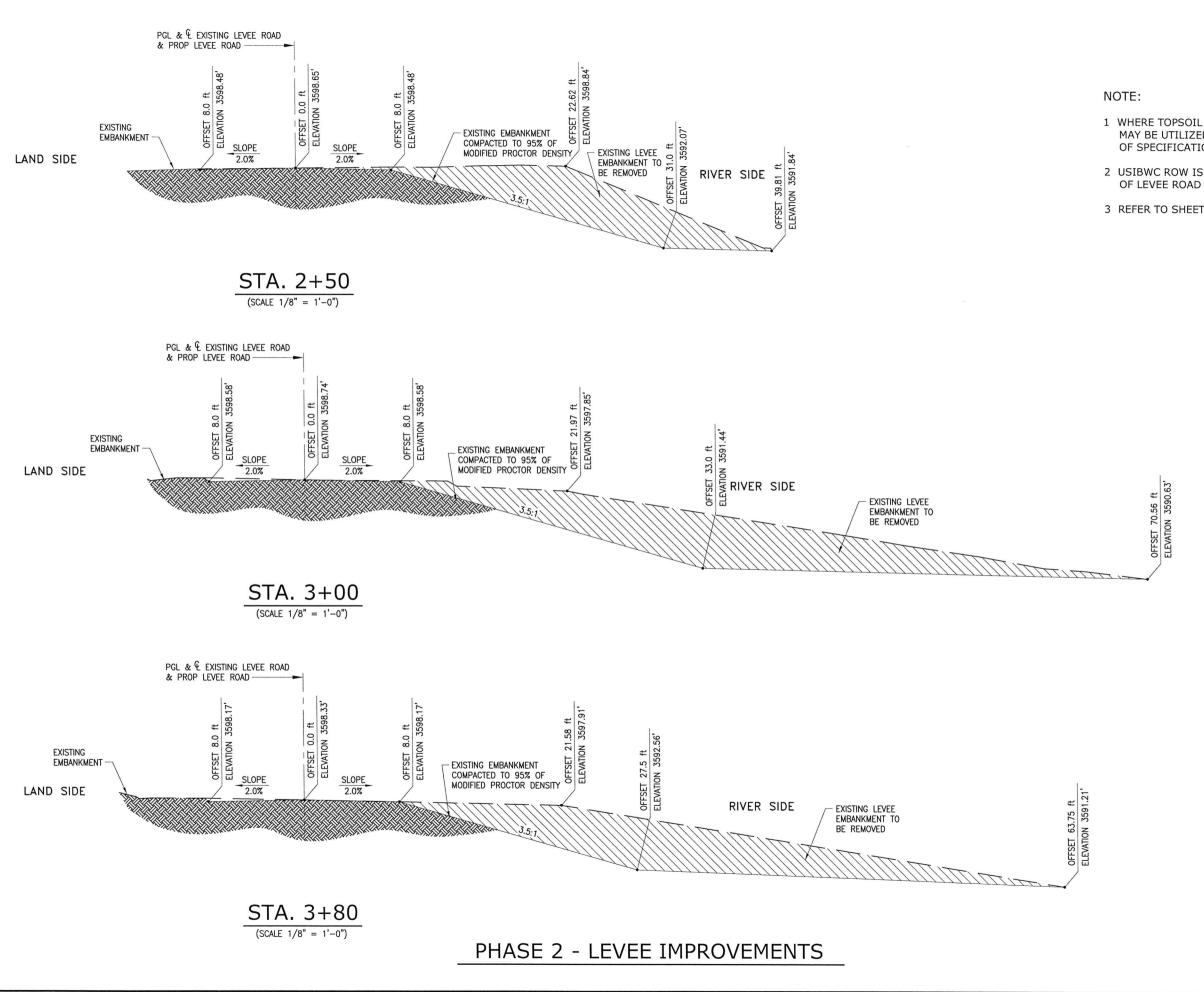

- 1 WHERE TOPSOIL IS CALLED OUT SALVAGED EXISTING TOPSOIL MAY BE UTILIZED PROVIDE THAT IT MEETS THE REQUIREMENTS OF SPECIFICATIONS 31.14.00 SEC. 3.2 AND 35.41.00 SEC. 2.2.
- 2 USIBWC ROW IS APPROXIMATELY 100 FT NORTH AND 250 FT SOUTH OF LEVEE ROAD CENTERLINE.
- 3 REFER TO SHEET S-9 FOR REQUIRED VEGETATION-FREE ZONE LIMITS.





## THE COUNTY OF EL PASO




STRUCTURAL ENGINEERING ASSOCIATES, INC.

CONSULTING ENGINEERS

DEMOLITION OF FABENS CASETA INTERNATIONAL BRIDGE


LEVEE ROAD CROSS SECTIONS

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A.M.H.	G.J.S.	9-14-16	
DWG. CK.	DESIGN CK.	DRAWING FILE	1 5-8
S.A.M.	S.A.M.	16-003C	0 0

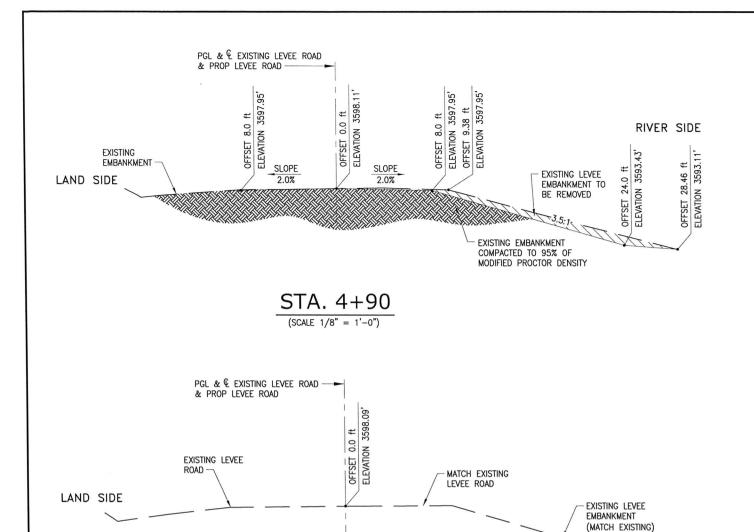

STA. 5+50(SCALE 1/8" = 1'-0")

PHASE 2 - LEVEE IMPROVEMENTS

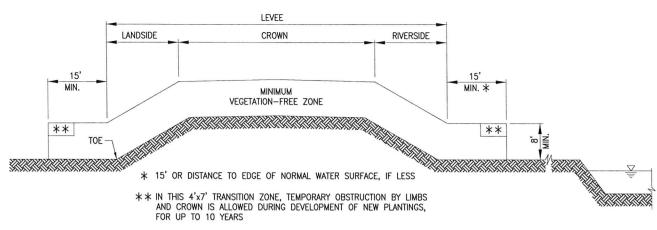

∇ NORMAL WATER SURFACE


RIVER SIDE

## VEGETATION-FREE ZONE

TYPICAL N.T.S.

#### NOTE:

- 1 WHERE TOPSOIL IS CALLED OUT SALVAGED EXISTING TOPSOIL MAY BE UTILIZED PROVIDE THAT IT MEETS THE REQUIREMENTS OF SPECIFICATIONS 31.14.00 SEC. 3.2 AND 35.41.00 SEC. 2.2.
- 2 USIBWC ROW IS APPROXIMATELY 100 FT NORTH AND 250 FT SOUTH OF LEVEE ROAD CENTERLINE.

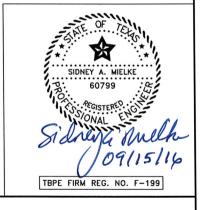



THE COUNTY OF EL PASO




STRUCTURAL ENGINEERING ASSOCIATES, INC.

CONSULTING ENGINEERS

DEMOLITION OF FABENS CASETA INTERNATIONAL BRIDGE


LEVEE ROAD CROSS SECTIONS

DWN.	DESIGN	DATE	SHEET NO.
A.M.H.	G.J.S.	9-14-16	
DWG. CK.	DESIGN CK.	DRAWING FILE	5-9
S.A.M.	S.A.M.	16-003C	0 0

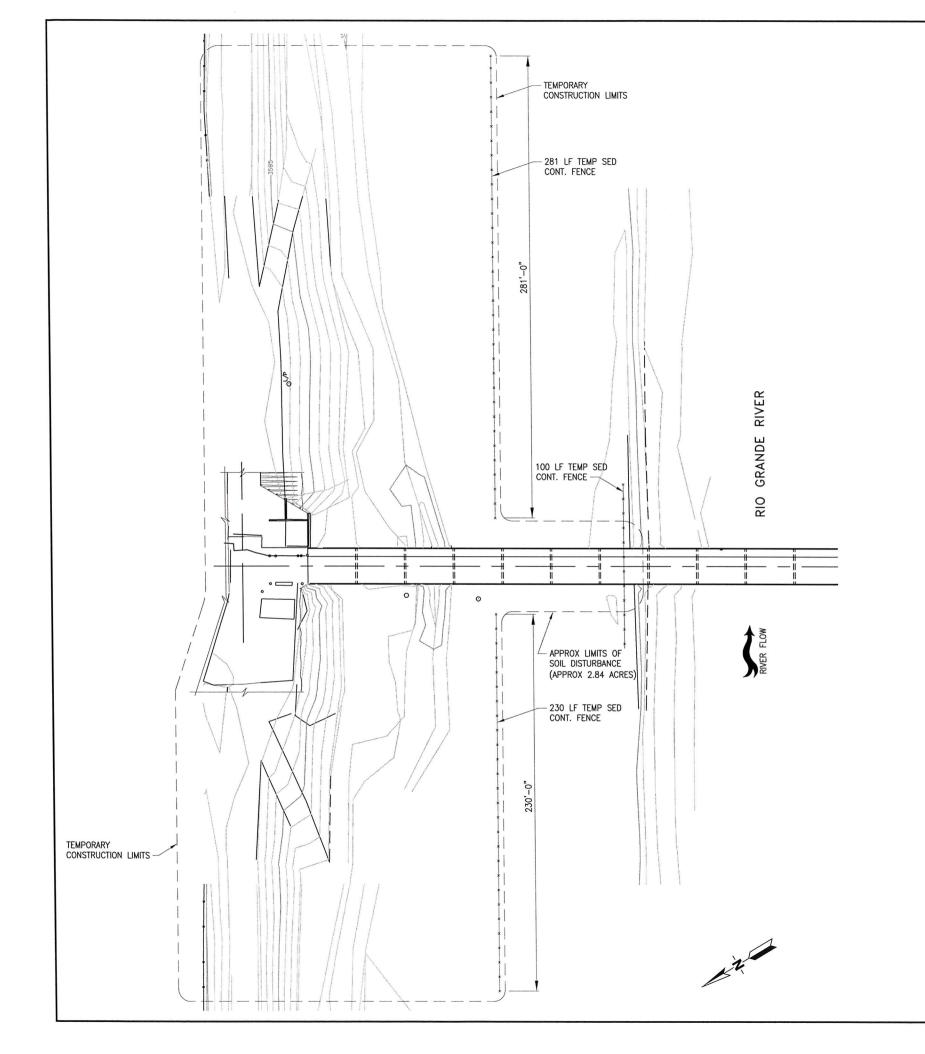

#### NOTE:

- 1 CONTRACTOR MAY NOT STORE AMY MATERIAL IN FLOODPLAIN.
- 2 TEMPORARY SEDIMENT CONTROL FENCES SHOWN HEREON ARE SUGGESTED BMP'S ONLY AND MAY BE MODIFIED BY THE CONTRACTOR'S SWPPP ENGINEER.
- 3 USIBWC ROW IS APPROXIMATELY 100 FT NORTH AND 250 FT SOUTH OF LEVEE ROAD CENTERLINE.

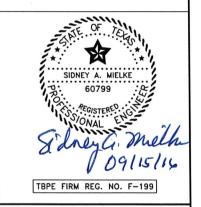



THE COUNTY OF EL PASO




STRUCTURAL ENGINEERING ASSOCIATES, INC.

CONSULTING ENGINEERS

DEMOLITION OF FABENS CASETA INTERNATIONAL BRIDGE

STORM WATER POLLUTION PREVENTION PLAN

DWN.	DESIGN	DATE	SHEET NO.
A.M.H.	G.J.S.	9-14-16	
DWG. CK.	DESIGN CK.	DRAWING FILE	1 S-10
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#### GENERAL NOTES

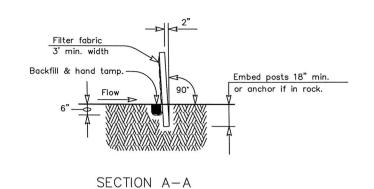The guidelines shown hereon are suggestions only and may be modified by the Contractor's SWPPP Engineer.

#### PLAN SHEET LEGEND


Sediment Control Fence




#### SEDIMENT CONTROL FENCE USAGE GUIDELINES

A sediment control fence may be constructed near the downstream perimeter of a disturbed area along a contour to intercept sediment from overland runoff. A 2 year storm frequency may be used to calculate the flow rate to be filtered.


Sediment control fence should be sized to filter a max. flow through rate of 100 GPM/FT . Sediment control fence is not recommended to control erosion from a drainage area larger than 2 acres.

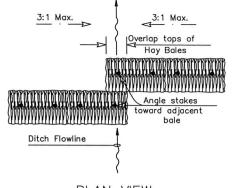


#### PLAN VIEW

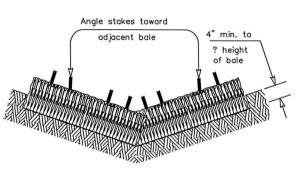

PROFILE VIEW

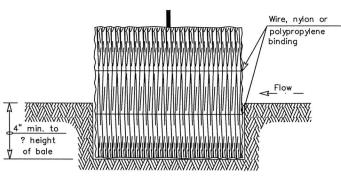

#### SECTION B-B

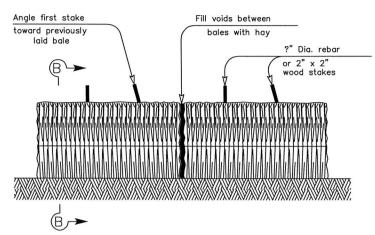


BALED HAY FOR EROSION CONTROL



#### PLANS SHEET LEGEND

Baled Hay

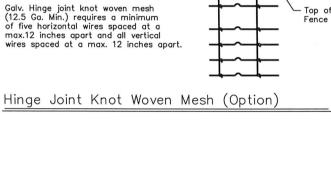



A Baled Hay installation may be constructed near the downstream perimeter of a disturbed area along a contour to intercept sediment from overland runoff. A two year storm frequency may be used to calculate the flow rate to be filtered. The installation should be sized to filter a maximum flow thru rate of 5 GPM/FT<sup>2</sup> of cross sectional area. Baled hay may be used at the following locations:

- Where the runoff approaching the baled hay flows over disturbed soil for less than 100'. If the slope of the disturbed soil exceeds 10%, the length of slope upstream the baled hay should be less than 50'.
- 2. Where the installation will be required for less than 3 months
- 3. Where the contributing drainage area is less than ? acre.

For Baled Hay installations in small ditches, the additional following considerations apply:

- 1. The ditch sideslopes should be graded as flat as possible to maximize the drainage flowrate thru the hay.
- 2. The ditch should be graded large enough to contain the overtopping drainage when sediment has filled to the top of the baled hav

Bales should be replaced usually every 2 months or more often during wet weather when loss of structural integrity is accelerated.



GENERAL NOTES

- Hay bales shall be bound by either wire or nylon or polypropylene string. The bales shall be composed entirely
- 3. Hay bales shall be embedded in the soil a minimum of 4" and where possible? the height of the bale.
- 4. Hay bales shall be placed in a row with ends tightly abutting the adjacent bales. The bales shall be placed with bindings parallel to the around.
- 5. Hay bales shall be securely anchored in place with ?" Dia. rebar or 2" x 2" wood stakes, driven through the bales. The first stake shall be angled towards the previously laid bale to force the bales together.
- 6. The guidelines shown hereon are suggestions only and may be modified by the Contractor's SWPPP Engineer
- 7. Refer to Specification Section 01.57.13 Temporary Environmental Controls





## THE COUNTY OF EL PASO




STRUCTURAL ENGINEERING ASSOCIATES. INC.

CONSULTING ENGINEERS


DEMOLITION OF FABENS CASETA INTERNATIONAL BRIDGE


TEMPORARY EROSION, SEDIMENT AND WATER POLLUTION CONTROL MEASURES FENCE & BALED HAY EC(1)-09

DWN.	DESIGN	DATE	SHEET NO.
A.M.H.	G.J.S.	9-14-16	
DWG. CK.	DESIGN CK.	DRAWING FILE	1 S-11
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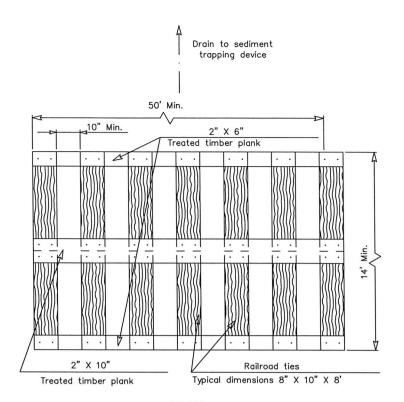


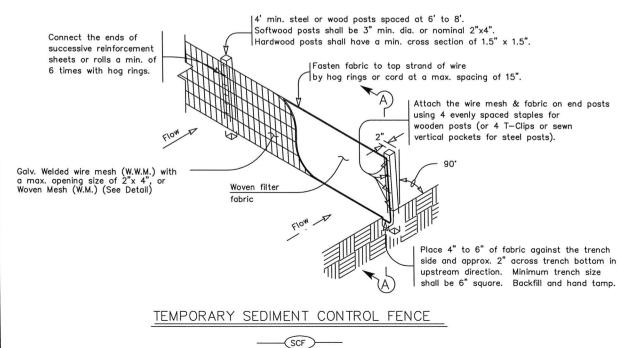**PROFILE** 


### CONSTRUCTION EXIT (TYPE 1)
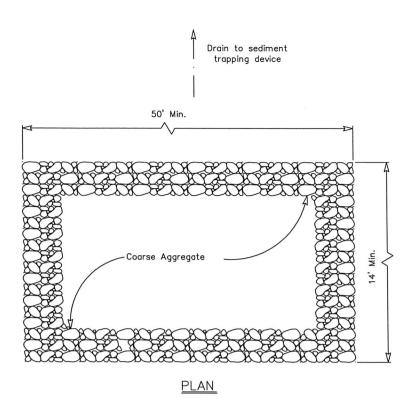
#### GENERAL NOTES

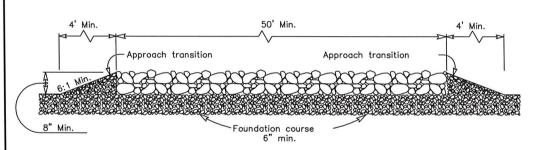- The length of the type 1 construction exit shall be as indicated on the plans, but not less than 50'.
- 2. The coarse aggregate should be open graded with a size of 4" to 8".
- 3. The approach transitions should be no steeper than 6:1 and constructed as directed by the Engineer.
- The construction exit foundation course shall be flexible base, bituminous concrete, portland cement concrete or other material as approved by the Contractor's SWPPP Engineer.
- The construction exit shall be graded to allow drainage to a sediment trapping device.
- 6. The guidelines shown hereon are suggestions only and may be modified by the Contractor's SWPPP Engineer.



<u>PLAN</u>

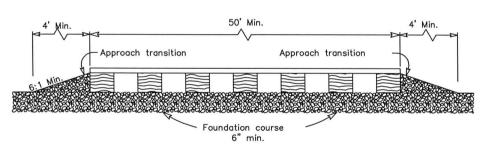


PROFILE


### CONSTRUCTION EXIT (TYPE 2)

#### GENERAL NOTES

- The length of the type 2 construction exit shall be as indicated on the plans, but not less than 50'.
- The treated timber planks shall be attached to the railroad ties with ?"x 6" min. lag bolts. Other fasteners may be used as approved by the Contractor's SWPPP Engineer.
- 3. The treated timber planks shall be #2 grade min., and should be free from large and loose knots.
- 4. The approach transitions shall be no steeper than 6:1 and constructed as directed by the Contractor's SWPPP Engineer.
- The construction exit foundation course shall be flexible base, bituminous concrete, portland cement concrete or other material as approved by the Contractor's SWPPP Engineer.
- 6. The construction exit should be graded to allow drainage to a sediment trapping device.
- The guidelines shown hereon are suggestions only and may be modified by the Contractor's SWPPP Engineer.

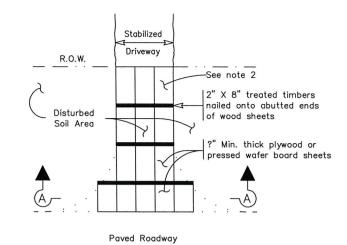

PLAN

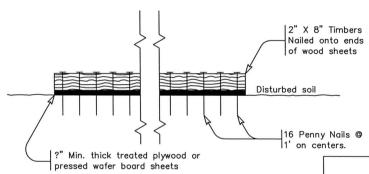

SECTION A-A

CONSTRUCTION EXIT (TYPE 3)

#### GENERAL NOTES

- The length of the type 3 construction exit shall be as shown on the plans, or as directed by the Contractor's SWPPP Engineer.
- The type 3 construction exit may be constructed from open graded crushed stone with a size of two to four inches spread a min. of 4" thick to the limits shown on the plans.
- The treated timber planks shall be #2 grade min., and should be free from large and loose knots.
- 4. The guidelines shown hereon are suggestions only and may be modified by the Contractor's SWPPP Engineer.



## THE COUNTY OF EL PASO



STRUCTURAL ENGINEERING ASSOCIATES, INC.

TBPE FIRM REG. NO. F-199

CONSULTING ENGINEERS

## DEMOLITION OF FABENS CASETA INTERNATIONAL BRIDGE

TEMPORARY EROSION, SEDIMENT AND WATER POLLUTION CONTROL MEASURES CONSTRUCTION EXITS EC (3)-93

WN.	DESIGN	DATE	SHEET NO.
A.M.H.	G.J.S.	9-14-16	500 to 1000
OWG. CK.	DESIGN CK.	DRAWING FILE	S-12
S.A.M.	S.A.M.	16-003C	0 12

#### NOTE:

 Refer to Specification Section 01.57.13 Temporary Environmental Controls.

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☐ Interceptor Swale ☐ Straw Bale Dike ☐ Wet Basin ☐ LIST OF ABBREVIATIONS ☐	
BMP: Best Management Practice SPCC: Spill Prevention Control and Countermeasure CGP: Construction General Permit SW3P: Storm Water Pollution Prevention Plan	
Erosion Control Compost Erosion Control Compost Mulch Filter Berm and Socks DSHS: Texas Department of State Health Services PCN: Pre-Construction Notification	
Mulch Filter Berm and Socks Mulch Filter Berm and Socks Commission on Environmental Quality	
Compost Filter Berm and Socks Compost Filter Berm and Socks Vegetation Lined Ditches  MOU: Memorandum of Understanding TPDES: Texas Pollutant Discharge Elimination System  MS4: Municipal Separate Stormwater Sewer SystemTPWD: Texas Parks and Wildlife Department  Environmental Controls.	_
Stolle Securities Traps Security Street Systems Main's ingratory Bird Treaty Act TXDUT: Texas Department of Transportation	Temporary
NWP: Nationwide Permit USACE: U.S. Army Corps of Engineers	
Sealment Basins NOI: Notice of Intent USFWS: U.S. Fish and Wildlife Service	Temporary

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## THE COUNTY OF EL PASO



STRUCTURAL ENGINEERING ASSOCIATES, INC.

TBPE FIRM REG. NO. F-199

CONSULTING ENGINEERS

DEMOLITION OF FABENS CASETA INTERNATIONAL BRIDGE

> ENVIRONMENTAL PERMITS, ISSUES AND COMMITMENTS EPIC

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A.M.H.	G.J.S.	9-14-16	
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